



B	28/07/2022	RJF	JP	IMCL	AB	CR21-131; Added Additional Inch Dimensions to the Clearance Text Note
A	2021-11-25	RJF	AT	JP	AB	CR21-039 AVC 1B UL project; First Issue, based on 2UCP074210, Dual Dimension Added
REV.	DATE	BY	CHK	CHK	APPD	DESC

<b>ABB</b> <b>PROPRIETARY AND CONFIDENTIAL</b> <small>THE INFORMATION CONTAINED IN THIS DRAWING IS HIGHLY CONFIDENTIAL AND THE SOLE PROPERTY OF ABB LTD. COPYRIGHT RESERVED. THIS DRAWING MUST NOT BE USED FOR ANY PURPOSE OTHER THAN THAT EXPRESSLY PERMITTED IN WRITING BY ABB LTD AND MUST NOT BE DISCLOSED OR REPRODUCED IN ANY WAY WITHOUT PERMISSION FROM ABB LTD IN WRITING. THE DRAWING MUST BE RETURNED TO TO ABB LTD WHEN THE PURPOSE FOR WHICH IT IS SUPPLIED HAS CEASED.</small>	<b>MATERIAL:</b>	<b>TITLE:</b> PCS100-07-208-0B5-40-UL PCS100 AVC-40 150kVA, 208V, 50/60Hz Mechanical Layout		<small>DIMENSIONS ARE IN MILLIMETRES UNLESS OTHERWISE STATED TOLERANCES (UNLESS OTHERWISE STATED) ISO2768 -v</small> <div>3RD ANGLE PROJECTION</div> <div>SCALE: 1:18</div> <div>CAD File: 2UCD074510E101_B</div> <div>DWG. NO. 2UCD074510E101</div> <div>SHEET 1 OF 2</div>	
	<b>FINISH:</b> Natural				
	<b>COMMENTS:</b> REMOVE ALL BURRS & SHARP EDGES				
	<b>DO NOT SCALE DRAWING</b>				
				REV B	

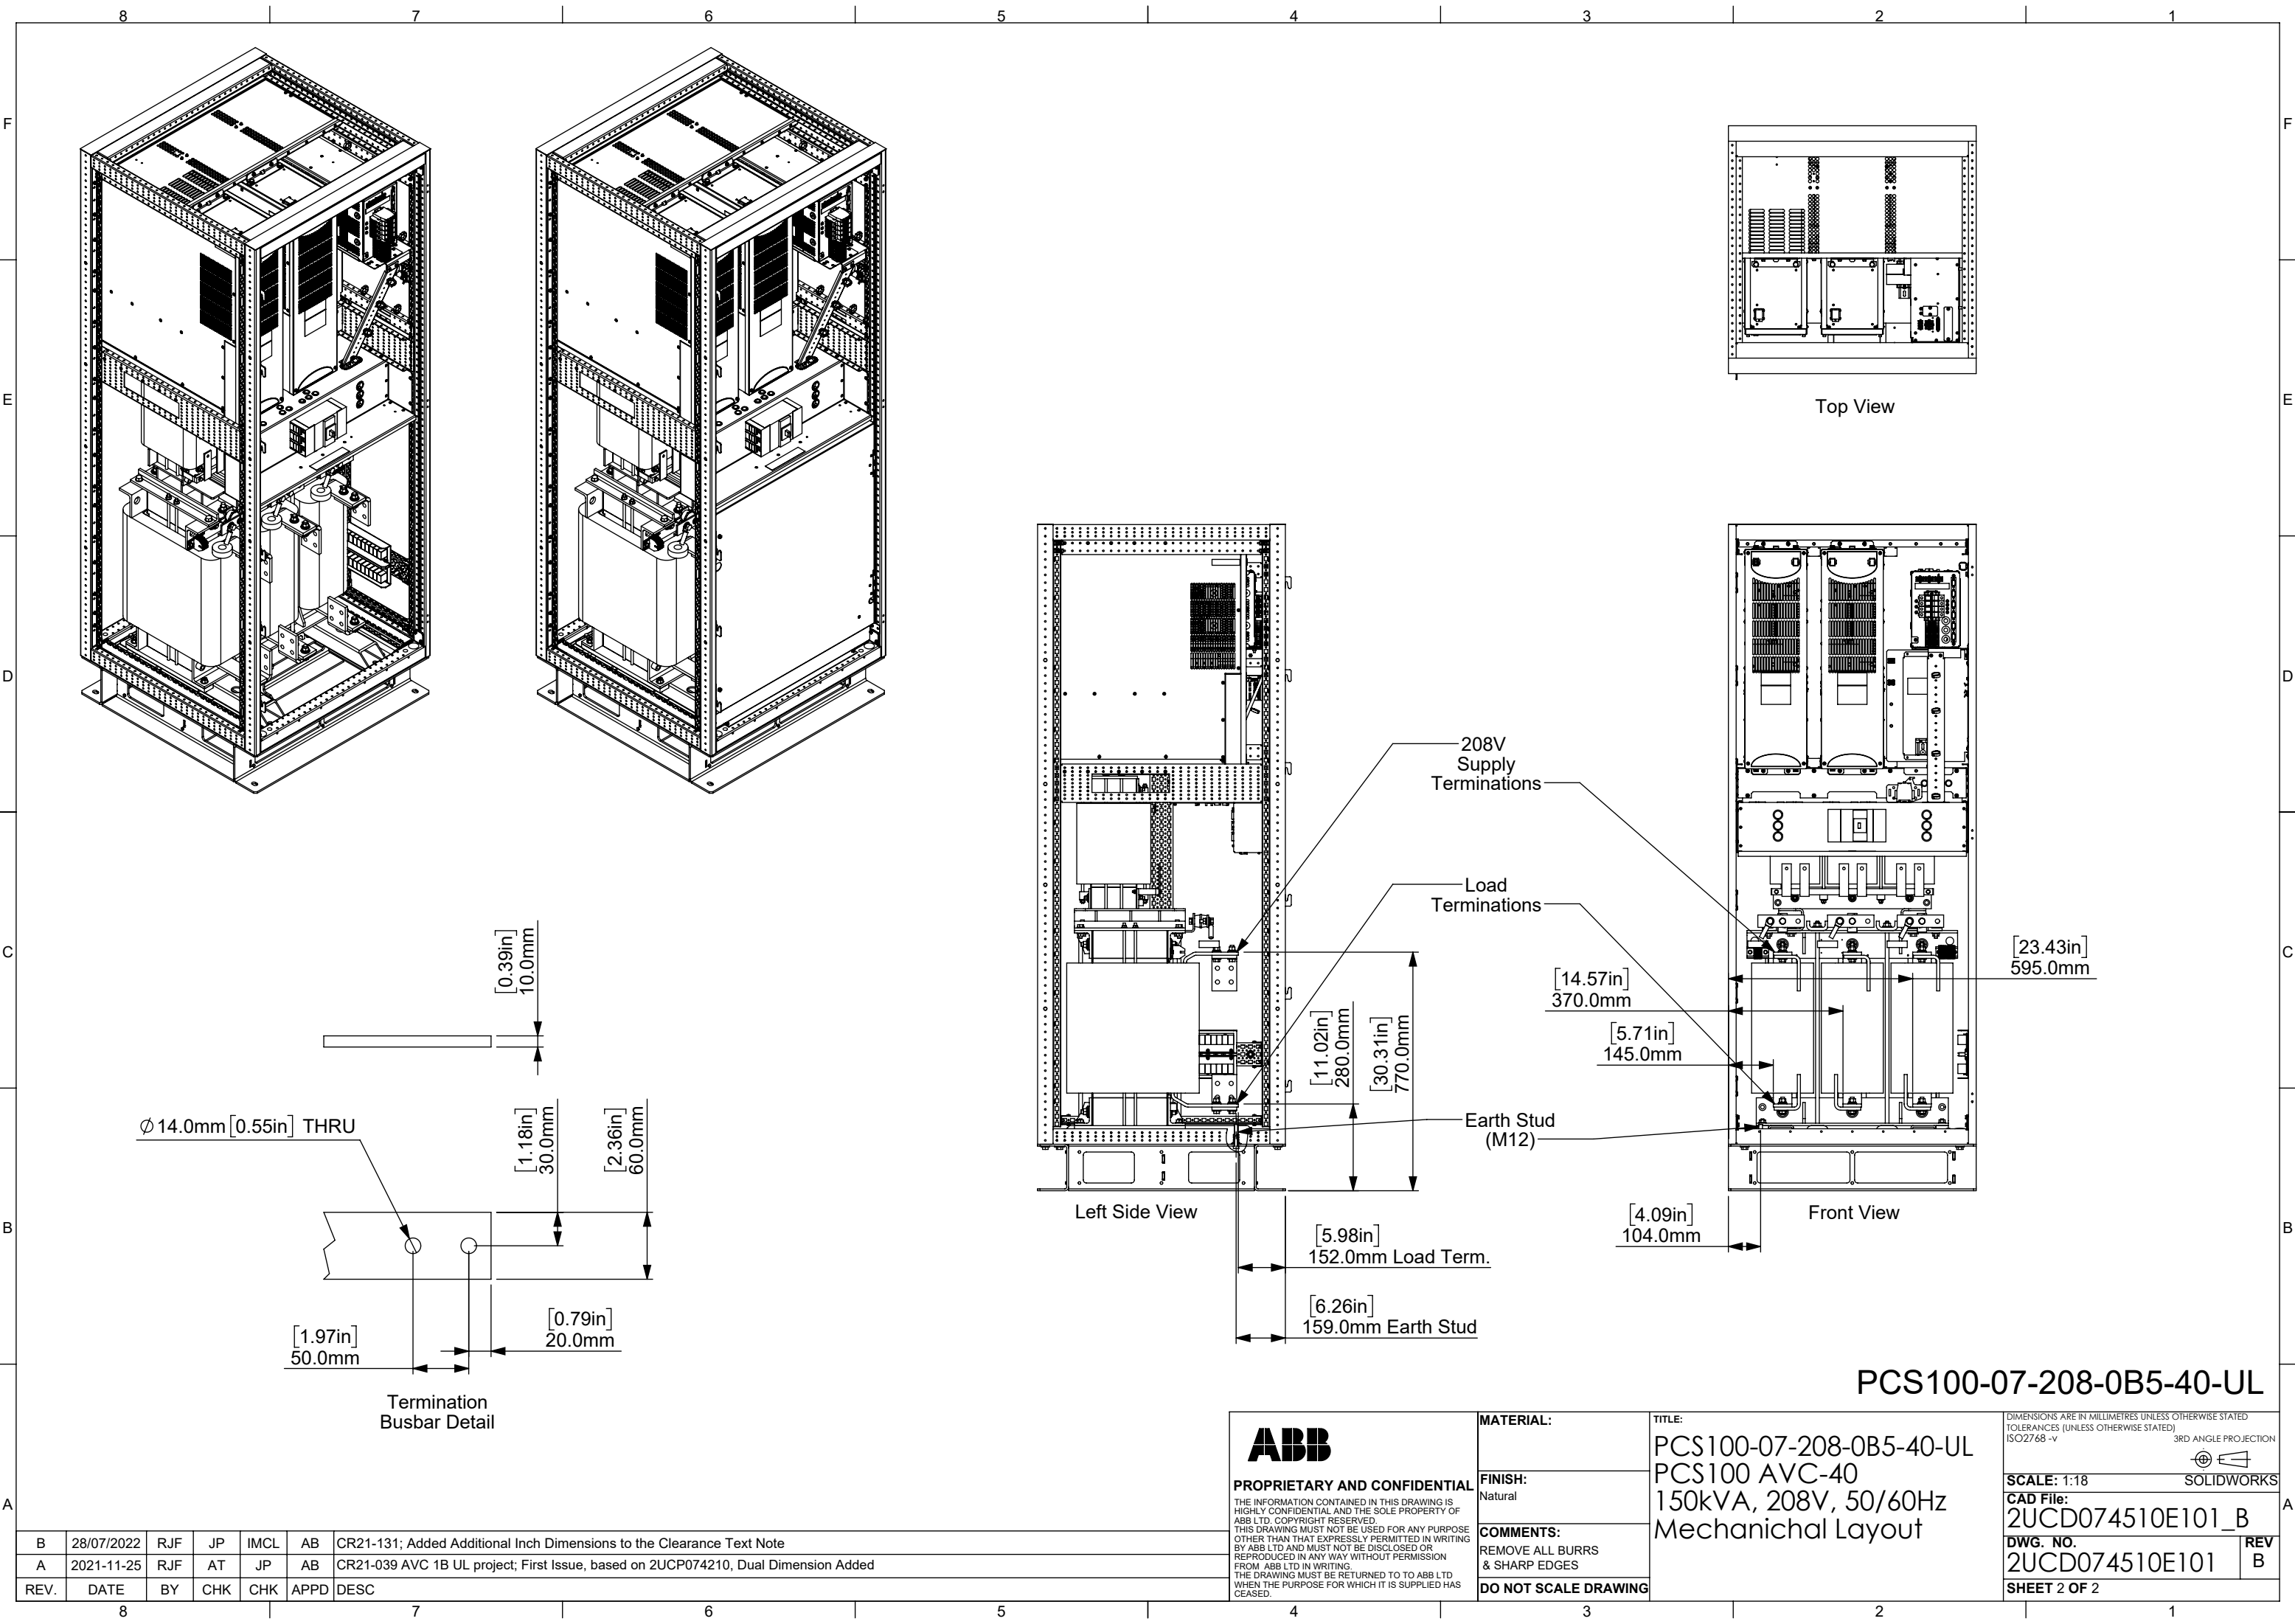

PCS100-07-208-0B5-40-UL

B	28/07/2022	RJF	JP	IMCL	AB	CR21-131; Added Additional Inch Dimensions to the Clearance Text Note
A	2021-11-25	RJF	AT	JP	AB	CR21-039 AVC 1B UL project; First Issue, based on 2UCP074210, Dual Dimension Added
REV.	DATE	BY	CHK	CHK	APPD	DESC
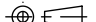
<div><div>ABB</div><div>PROPRIETARY AND CONFIDENTIAL</div><div>THE INFORMATION CONTAINED IN THIS DRAWING IS HIGHLY CONFIDENTIAL AND THE SOLE PROPERTY OF ABB LTD. COPYRIGHT RESERVED. THIS DRAWING MUST NOT BE USED FOR ANY PURPOSE OTHER THAN THAT EXPRESSLY PERMITTED IN WRITING BY ABB LTD AND MUST NOT BE DISCLOSED OR REPRODUCED IN ANY WAY WITHOUT PERMISSION FROM ABB LTD IN WRITING. THE DRAWING MUST BE RETURNED TO TO ABB LTD WHEN THE PURPOSE FOR WHICH IT IS SUPPLIED HAS CEASED.</div></div>	MATERIAL:	PCS100-07-208-0B5-40-UL PCS100 AVC-40 150kVA, 208V, 50/60Hz Mechanical Layout	DIMENSIONS ARE IN MILLIMETRES UNLESS OTHERWISE STATED TOLERANCES (UNLESS OTHERWISE STATED) ISO2768 -v	
	FINISH: Natural		3RD ANGLE PROJECTION 	
	COMMENTS: REMOVE ALL BURRS & SHARP EDGES		SCALE: 1:18 CAD File: 2UCD074510E101_B	
	DO NOT SCALE DRAWING		DWG. NO. 2UCD074510E101 REV B	
			SHEET 2 OF 2	